

CITY OF HAYWARD
HEART OF THE BAY

**DEPARTMENT OF PUBLIC WORKS
ENGINEERING DIVISION**

DESIGNED BY: _____ CHECKED BY: _____
DRAWN BY: _____ APPROVAL RECD: _____

APPROVED BY:
KATHY GARCIA **ALEX AMERI**
DEP. DIR. PUBLIC WORKS INTERIM DIR. PUBLIC WORKS

PROJ. NO. 07481 & 07482 **FILE NO. E-2157**

HAYWARD FIRE STATION #6 & FIRE TRAINING CENTER

1401 W. WINTON AVE.
HAYWARD, CA 94545

REVISIONS

No.	Description	Date

PERMIT SUBMITTAL



Sheet Title
**BUILDING 2
SLAB EDGE PLAN, FLOOR PLAN**

Drawn By: EW Checked By: EW

Scale:
As Indicated

Date:
September 21, 2018

Project No.: 2016039

2-A2.10
Drawing No.

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GENERAL SHEET NOTES


- SEE SHEET 2-A0.01 FOR ACCESSIBLE MOUNTING HEIGHTS AND CLEARANCES.
-

WALL LEGEND


- [Symbol] CONCRETE WALL, S.S.D. FOR THICKNESS & REINFORCING
- [Symbol] CMU WALL TO 8'-0" A.F.F., S.S.D. FOR THICKNESS & REINFORCING
- [Symbol] METAL STUD-FRAMED WALL PER WALL TYPE (SEE SHEET 2-A8.00)
- [Symbol] ALUMINUM CURTAIN WALL

SHEET KEYNOTE LEGEND


03 30.01	PROTECTIVE CONCRETE CASING @ BASE OF STEEL COLUMN, TYPICAL U.N.O.
03 30.16	6" HIGH CONCRETE WALL CURB, TYPICAL - WIDTH AS DETAILED
03 30.17	FLOOR SURFACE SLOPED TO TRENCH DRAINS, SEE DIMENSIONED FLOOR PLAN & PLUMBING DRAWINGS
03 30.18	FLOOR SURFACE SLOPED TO FLOOR DRAINS, S.P.D.
05 10.01	PAINTED STEEL COLUMN, S.S.D.
05 50.07	PAINTED ALUMINUM PLATE "PORTAL" AT HEAD & JAMBS OF APPARATUS BAY DOOR GROUP
10 40.01	SURFACE-MOUNTED FIRE EXTINGUISHER CABINET
10 50.01	METAL LOCKERS
10 50.02	WOOD LOCKERS WITH INTEGRATED BENCH
22 40.01	PREMANUFACTURED TRENCH DRAIN WITH GALVANIZED STEEL FRAME AND DUCTILE IRON GRATE, TYPICAL

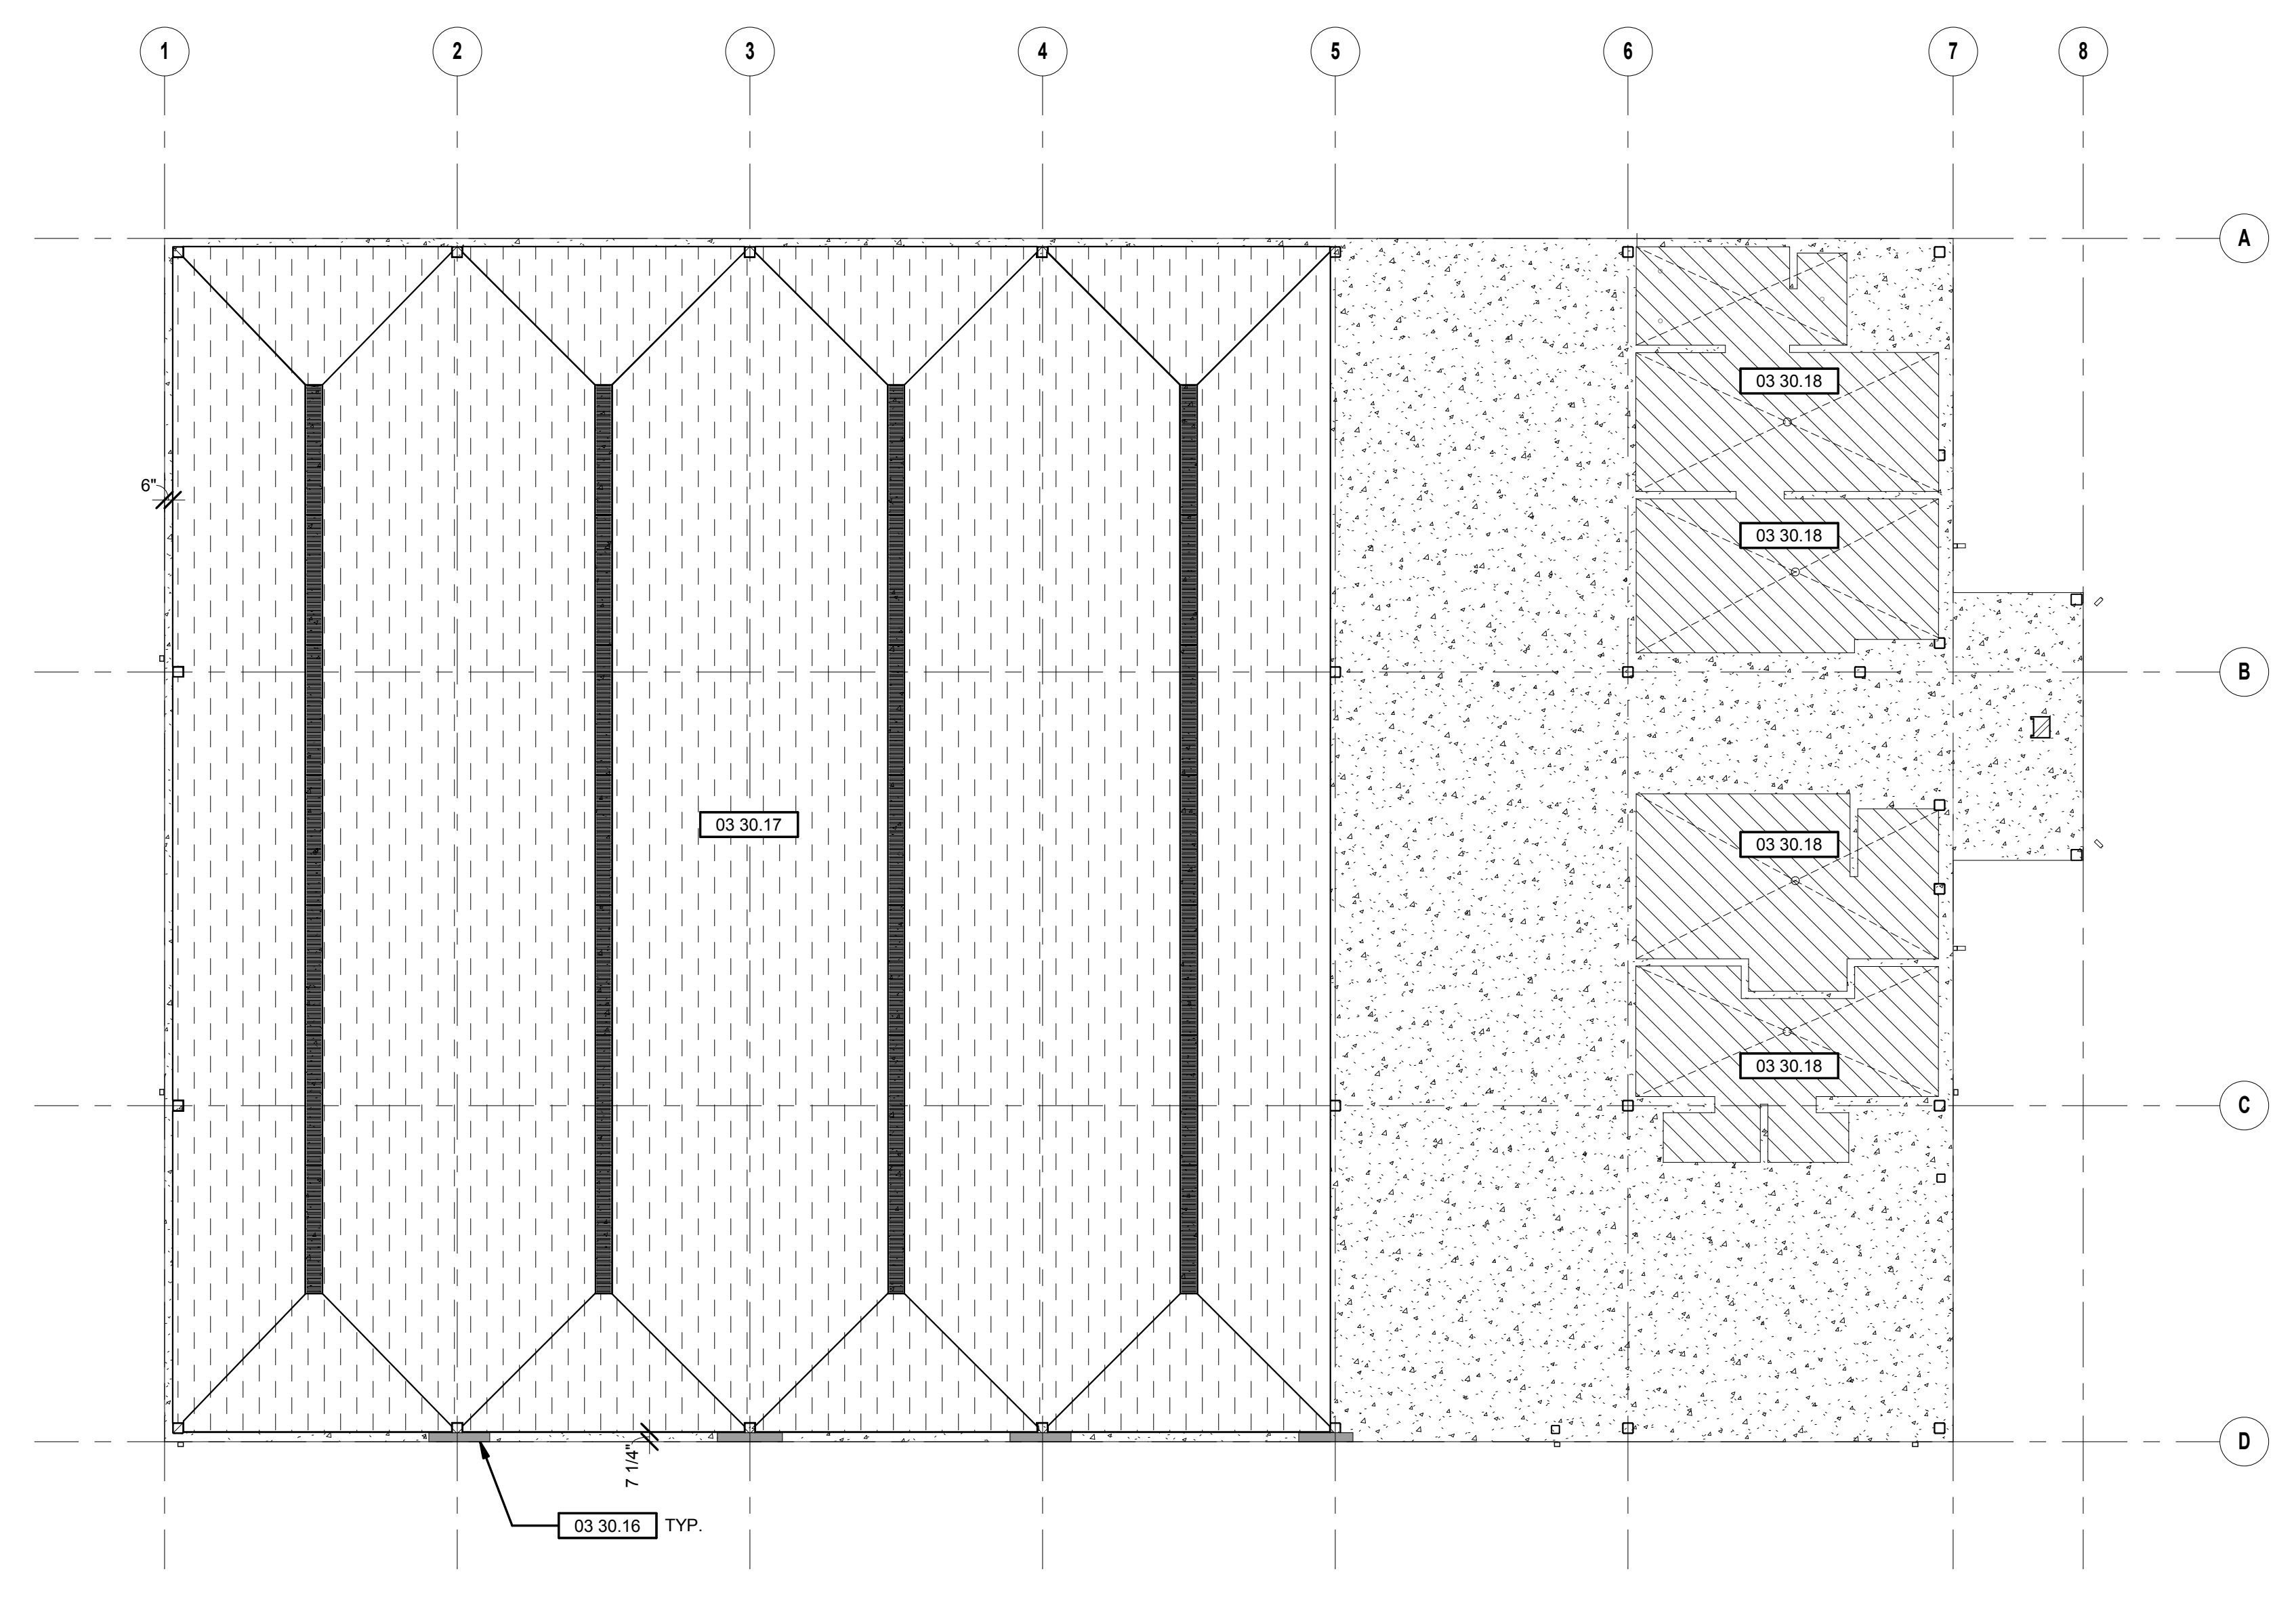


1 SLAB EDGE PLAN
1/8" = 1'-0"

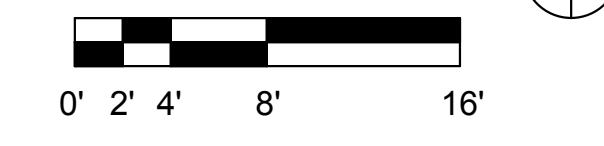

2 FLOOR PLAN
1/8" = 1'-0"

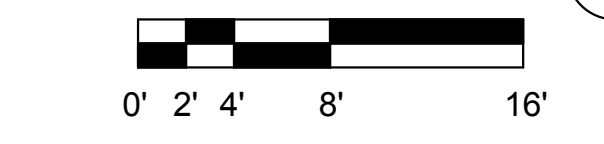

SLAB TYPE LEGEND

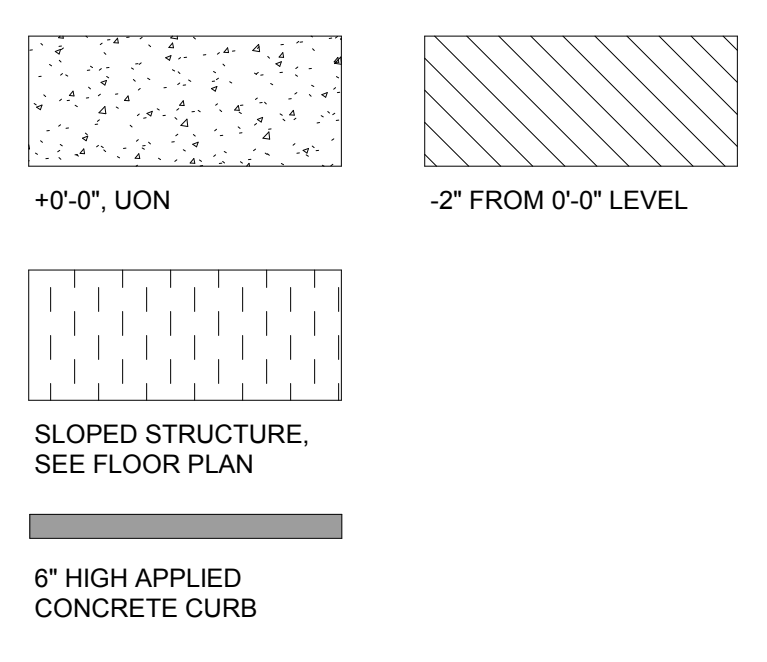

GENERAL NOTES

- REFER TO DETAILS FOR SIZE AND PLACEMENT OF CONCRETE CURBS
- SEE DETAIL 2/2-A9.01 FOR WATERPROOFING OF SLAB PENETRATIONS
- SEE DETAIL 3/2-A9.01 FOR GUIDE TO LAPPING OF UNDERSLAB WATERPROOFING JOINTS

ALIGNMENT GUIDE

- GUIDE TO LOCATE SLAB EDGES
- EXTERIOR EDGES (DIMENSIONS ON FLOOR PLANS)
- INTERIOR EDGES (DIMENSIONS ON FLOOR PLANS) AND AS FOLLOWS:
- TILE FLOOR RECESSES: RECESS EDGES SHALL ALIGN WITH OUTSIDE F.O. TILE BACKER BOARD
 - VISIBLE WALL FINISH PASSING SLAB EDGE: OUTER EXTENTS OF BENT PL AND WALL FRAMING SHALL ALIGN